

Site Plan (Incorporating Site Management Plan/ Site Scale: 1:200 Analysis Plan

Issue	Description:	Date:
Α	development application issue	05/08/23

All dimensions are to be checked on site prior to work commencement. Verify all boundary setbacks by survey where required. Levels shown are approximate only and are to be verified on site prior to work commencement. Use figure dimensions in all cases in preference to measurements scaled off the drawings.


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Dwelcom
DWELCOM PTY LTD
Unit A/26 Cassola PI, Penrith NSW 2750

Unit A/26 Cassola PI, Penrith NSW 2750	ŀ
Builders Lic No: 150910C Contractor ABN: 60 094 173 001	l
Phone: 1300 393 526	l

			<u> </u>
	Project:	Proposed Secondary Dwelling	Scale: 1:200
	Address	31 Ottiwell Street	Drawn: ASV
		Goulburn NSW	LOT 4 DP 32628
1	Client:	Arianne David	Drawing No: 230625-01

		Window & Door Schedule				
	A	В	С	D	E	F
	Window No	Code	Frame size	Stud opening	Glazing type	Location
	W01	XO0909	860X850	920X910	clear	kitchen
	W02	D1509	1460X850	1520X910	clear	bed 1
8	W03	D1509	1460X850	1520X910	clear	bed 1
ê	W04	XO1212	1200X1210	1260X1270	clear	bed 2
windows	W05	XO0606	600X610	660X670	opaque	bath/ldy
>	W06	XO1212	1200X1210	1260X1270	clear	living
doors	D01	SF2118	2100X1810	2130X1870	clear	living
ŏ						

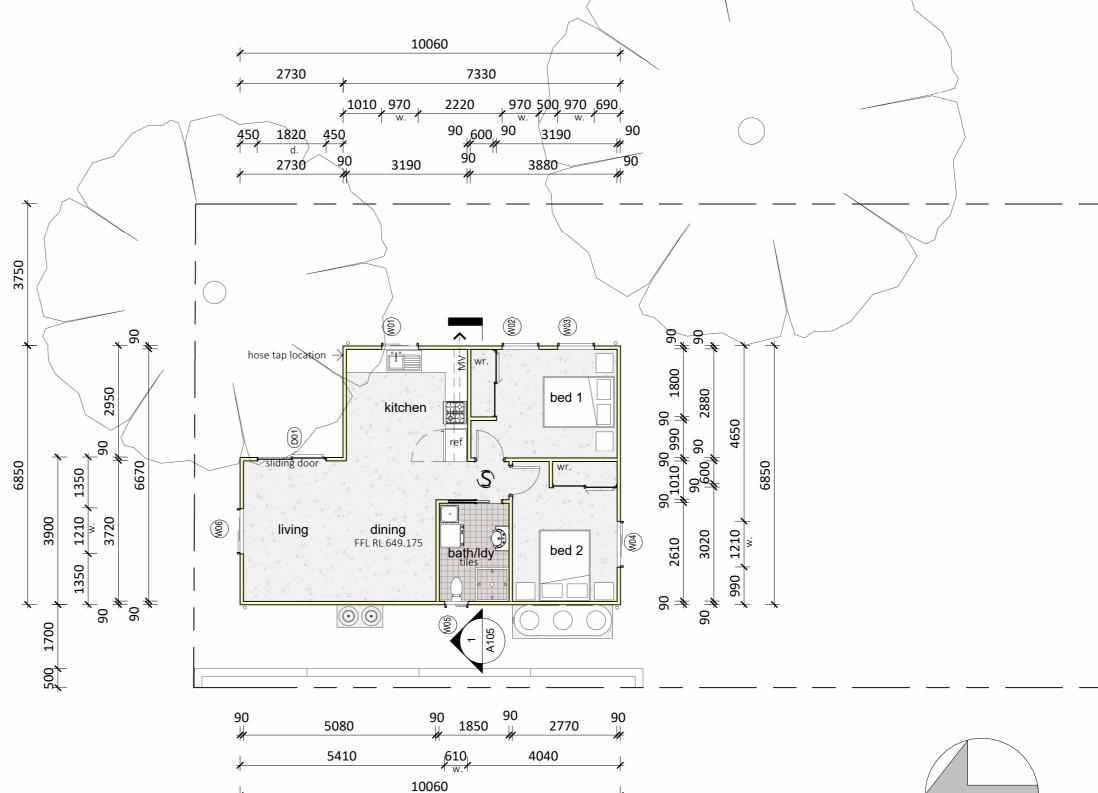

Floor Plan

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MV- provide mechanical ventilation	
discharge location all to comply with	
as per BCA Part 3.8.7.4	
hardwired smoke alarm installed and interconnected in accordance	ce
with BCA requirements	

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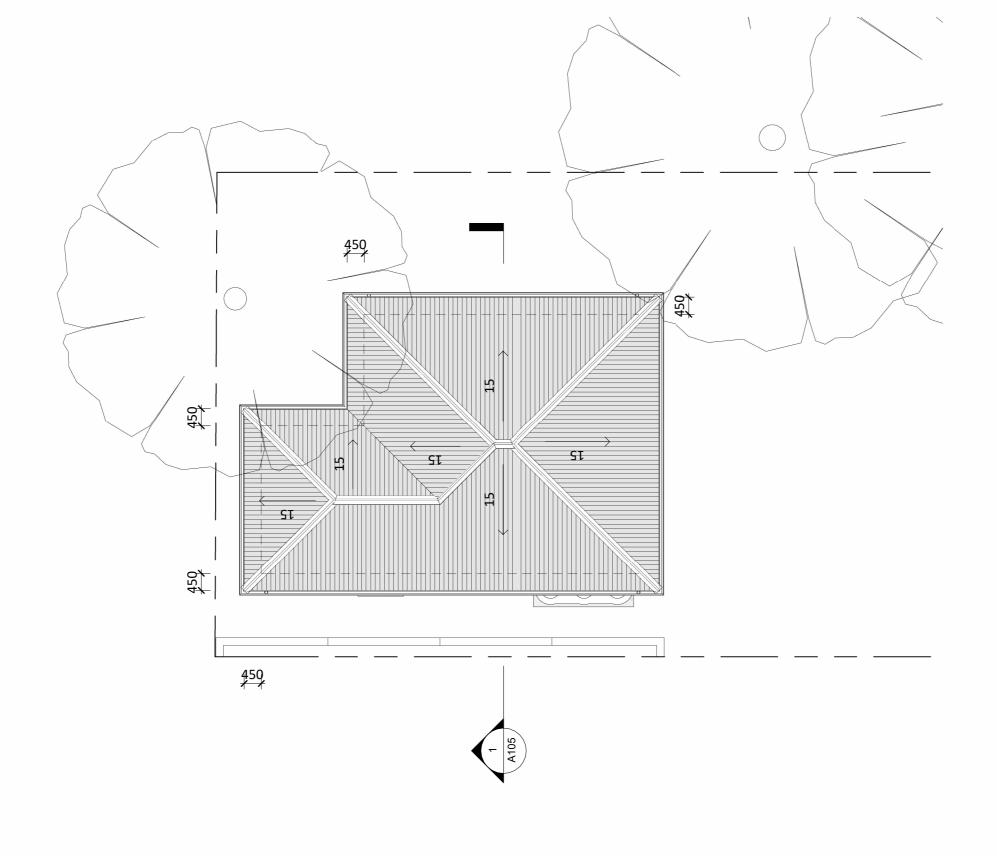
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Unit A/26 Cassola PI, Penrith NSW 2750 Builders Lic No: 150910C Contractor ABN: 60 094 173 00 Phone: 1300 393 526

Secondary Dwelling	Scale: 1:100
Street	Drawn: ASV
ISW	LOT 4 DP 32628
vid	Drawing No: 230625-02
	Street SW



Roof Plan

Issue	Description:	Date:	Al
Α	development application issue	05/08/23	Ve ar
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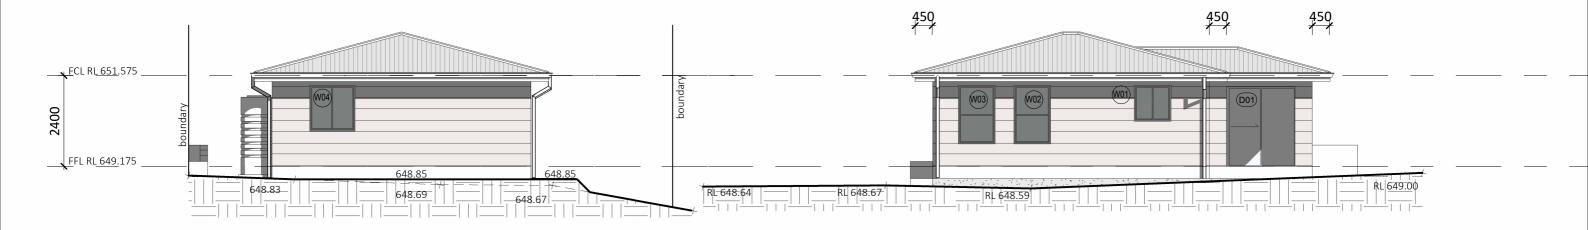
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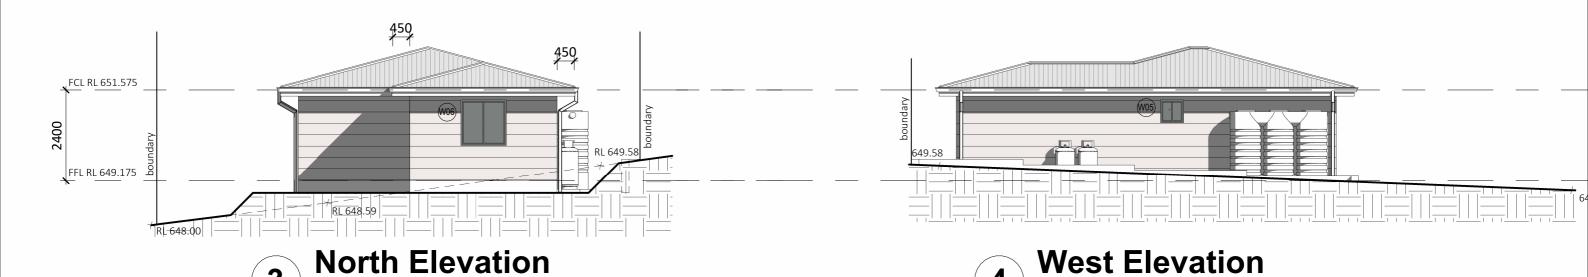
Project: Proposed Secondary Dwelling	Scale: 1:100
Address: 31 Ottiwell Street	Drawn: ASV
Goulburn NSW	LOT 4 DP 32628
Client: Arianne David	Drawing No: 230625-03
	Address: 31 Ottiwell Street Goulburn NSW



1 South Elevation

1:100

2 East Elevation
1:100



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Phone: 1300 393 526

	Project:	Proposed Secondary Dwelling	Scale: 1:100
	Address	31 Ottiwell Street	Drawn: ASV
		Goulburn NSW	LOT 4 DP 32628
7 50 173 001	Client:	Arianne David	Drawing No: 230625-04



Single Dwelling

Certificate number: 14133735

This certificate confirms that the proposed development will meet the NSW powerment's requirements for suisantiability, if it is bill in accordance with the commitments set out below. Terms used in this certificate, or in the commitments, have the meaning given by the document entitled "SAIX Definitions" dated 10/09/2020 published by the Department. This document is available at www.basix.nsv.gov.au.

Date of issue: Friday, 11 August 2023

To be valid, this certificate must be lodged within 3 months of the date of issue.



Project name	David-Goulburn	David-Goulbum		
Street address	31 Ottiwell Street G	31 Ottiwell Street Goulburn 2580		
Local Government Area	Goulburn Mulwaree	Council		
Plan type and plan number	deposited 32628			
Lot no.	4			
Section no.	-			
Project type	separate dwelling h dwelling	separate dwelling house - secondary dwelling		
No. of bedrooms	2			
Project score				
Water	✓ 42	Target 40		
Thermal Comfort	✓ Pass	Target Pass		
Energy	✓ 45	Target 40		

Certificate Prepared by
Name / Company Name: Dwelcom
ABN (f applicable): 60094173001

Description of project

Project name	David-Goulburn
Street address	31 Ottiwell Street Goulburn 2580
Local Government Area	Goulburn Mulwaree Council
Plan type and plan number	Deposited Plan 32628
Lot no.	4
Section no.	-
Project type	
Project type	separate dwelling house - secondary dwelling
No. of bedrooms	2
Site details	
Site area (m²)	1086
Roof area (m²)	80
Conditioned floor area (m2)	55.0
Unconditioned floor area (m2)	5.0
Total area of garden and lawn (m2)	400
Roof area (m2) of the existing dwelling	158
No. of bedrooms in the existing dwelling	3

Assessor number	n/a	
Certificate number	n/a	
Climate zone	n/a	
Area adjusted cooling load (MJ/m².year)	n/a	
Area adjusted heating load (MJ/m².year)	n/a	
Ceiling fan in at least one bedroom	n/a	
Ceiling fan in at least one living room or other conditioned area	n/a	
Project score		
Water	✓ 42	Target 40
Thermal Comfort	✓ Pass	Target Pass
Energy	✓ 45	Target 40

Schedule of BASIX commitments

The commitments set out below regulate how the proposed development is to be carried out. It is a condition of any development consent granted, or complying development certificate issued, for the proposed development, that BASIX commitments be complied with.

Water Commitments	Show on DA plans	Show on CC/CDC plans & specs	Certifier check
Landscape			
The applicant must plant indigenous or low water use species of vegetation throughout 300 square metres of the site.	~	~	
Fixtures			
The applicant must install showerheads with a minimum rating of 4 star (> 4.5 but <= 6 L/min plus spray force and/or coverage tests) in all showers in the development.		~	~
The applicant must install a toilet flushing system with a minimum rating of 6 star in each toilet in the development.		~	~
The applicant must install taps with a minimum rating of 6 star in the kitchen in the development.		~	
The applicant must install basin taps with a minimum rating of 6 star in each bathroom in the development.		~	
Alternative water			
Rainwater tank			
The applicant must install a rainwater tank of at least 3000 litres on the site. This rainwater tank must meet, and be installed in accordance with, the requirements of all applicable regulatory authorities.	~	~	~
The applicant must configure the rainwater tank to collect rain runoff from at least 60 square metres of the roof area of the development (excluding the area of the roof which drains to any stormwater tank or private dam).		~	~
The applicant must connect the rainwater tank to:			
all tollets in the development		-	-
the cold water tap that supplies each clothes washer in the development.		-	~
 at least one outdoor tap in the development (Note: NSW Health does not recommend that rainwater be used for human consumption in areas with potable water supply.) 			

Thermal Comfort Commitments	Show on DA plans	Show on CC/CDC plans & specs	Certifier check	
General features				
The dwelling must not have more than 2 storeys.	-	~	~	
The conditioned floor area of the dwelling must not exceed 300 square metres.	~	~	~	
The dwelling must not contain open mezzanine area exceeding 25 square metres.	~	~	~	
The dwelling must not contain third level habitable attic room.	~	~	~	
Floor, walls and ceiling/roof				
The applicant must construct the floor(s), walls, and ceiling/roof of the dwelling in accordance with the specifications listed in the table below.	-	~	~	

Construction	Additional insulation required (R-Yalue)	Other specifications
floor - concrete slab on ground	nil	
external wall - framed (weatherboard, fibre cement, metal clad)	3.40 (or 3.80 including construction)	
ceiling and roof - flat ceiling / pitched roof	ceiling: 5 (up), roof: foil/sarking	unventilated; medium (solar absorptance 0.475-0.70)

Note	 Insulation specified in this Certificate must be installed in accordance with Part 3.12.1.1 of the Building Code of Australia.
Note	 In some climate zones, insulation should be installed with due consideration of condensation and associated interaction with adjoining building materials.


Thermal Comfort Commitments		Show on CC/CDC plans & specs	Certifier check		
Windows, glazed doors and skylights	Windows, glazed doors and skylights				
The applicant must install the windows, glazed doors and shading devices described in the table below, in accordance with the specifications listed in the table. Relevant overshadowing specifications must be satisfied for each window and glazed door.	~	~	~		
The dwelling may have 1 skylight (<0.7 square metres) which is not listed in the table.		~	~		
The following requirements must also be satisfied in relation to each window and glazed door:		J	_		
For the following glass and frame types, the certifier check can be performed by visual inspection.					
- Aluminium single clear					
- Aluminium double (air) clear					
- Timber/uPVC/fbreglass single clear					
- Timber/uPVC/fibreglass double (air) clear					

Window/glazed door no.	Maximum height (mm)	(mm)	Туре	Shading Device (Dimension within 10%)	Overshadowing		
North facing	North facing						
W06	1200	1200	aluminium, single, clear	eave 450 mm, 150 mm above head of window or glazed door	not overshadowed		
East facing	East facing						
D01	2100	1800	aluminium, single, clear	eave 450 mm, 150 mm above head of window or glazed door	not overshadowed		
W01	900	900	aluminium, single, clear	eave 450 mm, 150 mm above head of window or glazed door	not overshadowed		
W02	1500	900	aluminium, single, clear	eave 450 mm, 150 mm above head of window or glazed door	not overshadowed		
W03	1500	900	aluminium, single, clear	eave 450 mm, 150 mm above head of window or glazed door	not overshadowed		
South facing							

Window/glazed door no.	Maximum height (mm)	Maximum width (mm)	Туре	Shading Device (Dimension within 10%)	Overshadowing
W04	1200	1200	aluminium, single, clear	eave 450 mm, 150 mm above head of window or glazed door	not overshadowed
West facing					
W05	600	600	aluminium, single, clear	eave 450 mm, 150 mm above head of window or glazed door	not overshadowed

Energy Commitments	Show on DA plans	Show on CC/CDC plans & specs	Certifier check
Hot water			
The applicant must install the following hot water system in the development, or a system with a higher energy rating: gas storage with a performance of 5 stars.	~	~	~
Cooling system			
The applicant must install the following cooling system, or a system with a higher energy rating, in at least 1 living area: 1-phase airconditioning; Energy rating; EER 3.5 - 4.0		~	~
The applicant must install the following cooling system, or a system with a higher energy rating, in at least 1 bedroom: 1-phase airconditioning; Energy rating: EER 3.5 - 4.0		~	~
Heating system			
The applicant must install the following heating system, or a system with a higher energy rating, in at least 1 living area: 1-phase airconditioning; Energy rating: 5 star (cold zone)		~	~
The applicant must install the following heating system, or a system with a higher energy rating, in at least 1 bedroom: 1-phase airconditioning; Energy rating: 5 star (cold zone)		~	~
Ventilation			
The applicant must install the following exhaust systems in the development:			
At least 1 Bathroom: no mechanical ventilation (ie. ratural); Operation control: n/a		•	~
Kitchen: no mechanical ventilation (ie. natural); Operation control: n/a			-
Laundry: natural ventilation only, or no laundry; Operation control: n/a			
Artificial lighting			
The applicant must ensure that the "primary type of artificial lighting" is fluorescent or light emitting diode (LED) lighting in each of the following rooms, and where the word "dedicated" appears, the fittings for those lights must only be capable of accepting fluorescent or light emitting diode (LED) lamps.			
at least 2 of the bedrooms / study; dedicated		_	-
at least 2 of the living / dining rooms; dedicated		•	~
the kitchen; dedicated		•	-

	1 1	•	
Energy Commitments	Show on DA plans	Show on CC/CDC plans & specs	Certifier
all bathrooms/toilets; dedicated		~	~
the laundry; dedicated		~	-
all hallways; dedicated		•	-
Natural lighting			
The applicant must install a window and/or skylight in 1 bathroom(s)/toilet(s) in the development for natural lighting.	~	~	~
Other			
The applicant must install a gas cooktop & electric oven in the kitchen of the dwelling.		~	
The applicant must construct each refrigerator space in the development so that it is "well ventilated", as defined in the BASIX definitions.		~	
The applicant must install a fixed outdoor clothes drying line as part of the development.		~	

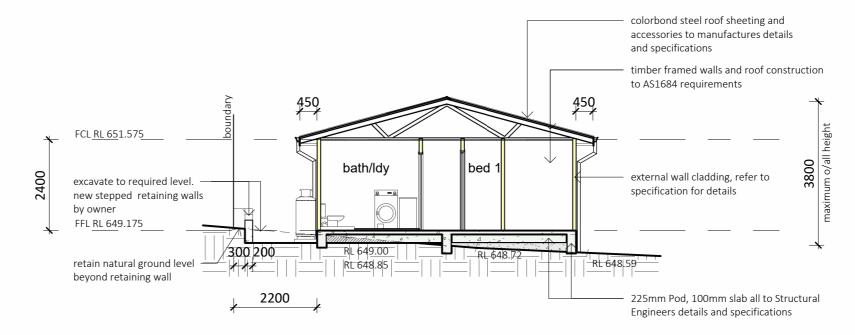

Section 1: 100

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	Address	31 Ottiwell Street	Drawn: ASV
		Goulburn NSW	LOT 4 DP 32628
1	Client:	Arianne David	Drawing No: 230625-05



Landscape Calculations Plan

Landscape Calculations:-

total site cover 388.00m2 (35.5%)

landscape area provided 698.60m2 (64.5%)

	Issue	Description:	Date:	
	Α	development application issue	05/08/23	۱
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	Goulburn NSW	LOT 4 DP 32628
Client:	Arianne David	Drawing No: 230625-06
I		